


NOTES:

1. 'CALCAMITE' STEP IRONS TO BE PROVIDED IN MANHOLES > 1.0m DEEP
2. STEP IRONS TO BE SPACED AT 300mm CRS VERTICALLY AND STAGGERED AT 200mm CRS HORIZONTALLY. STARTING 500mm BELOW COVER LEVEL.
3. BUTT-JOINT OR SIMILAR BITUMEN COMPOUND TO BE USED AS A JOINT SEALANT BETWEEN MANHOLE RINGS.
4. BENCHING TO BE FINISHED WITH MIN. 20mm THICK 1:3 CEMENT MORTAR
5. COUPLINGS TO BE PROVIDED IMMEDIATELY OUTSIDE MANHOLE ON EACH BRANCH AND OUTLET.

CHAMBER SCHEDULE		
DEPTH COVER TO MH INVERT	BRICKWORK THICKNESS	BASE SLAB THICKNESS
m	mm	mm
UP TO 2	230	150
2 TO 5	345	200
5 TO 10	575	300

REINFORCEMENT SCHEDULE		
DEPTH BELOW COVER	REINFORCING STEEL AT EACH COURSE	
m	No.	mm(
UP TO 2	2	Y6
2 TO 5	2	Y6
5 TO 8	2	Y8

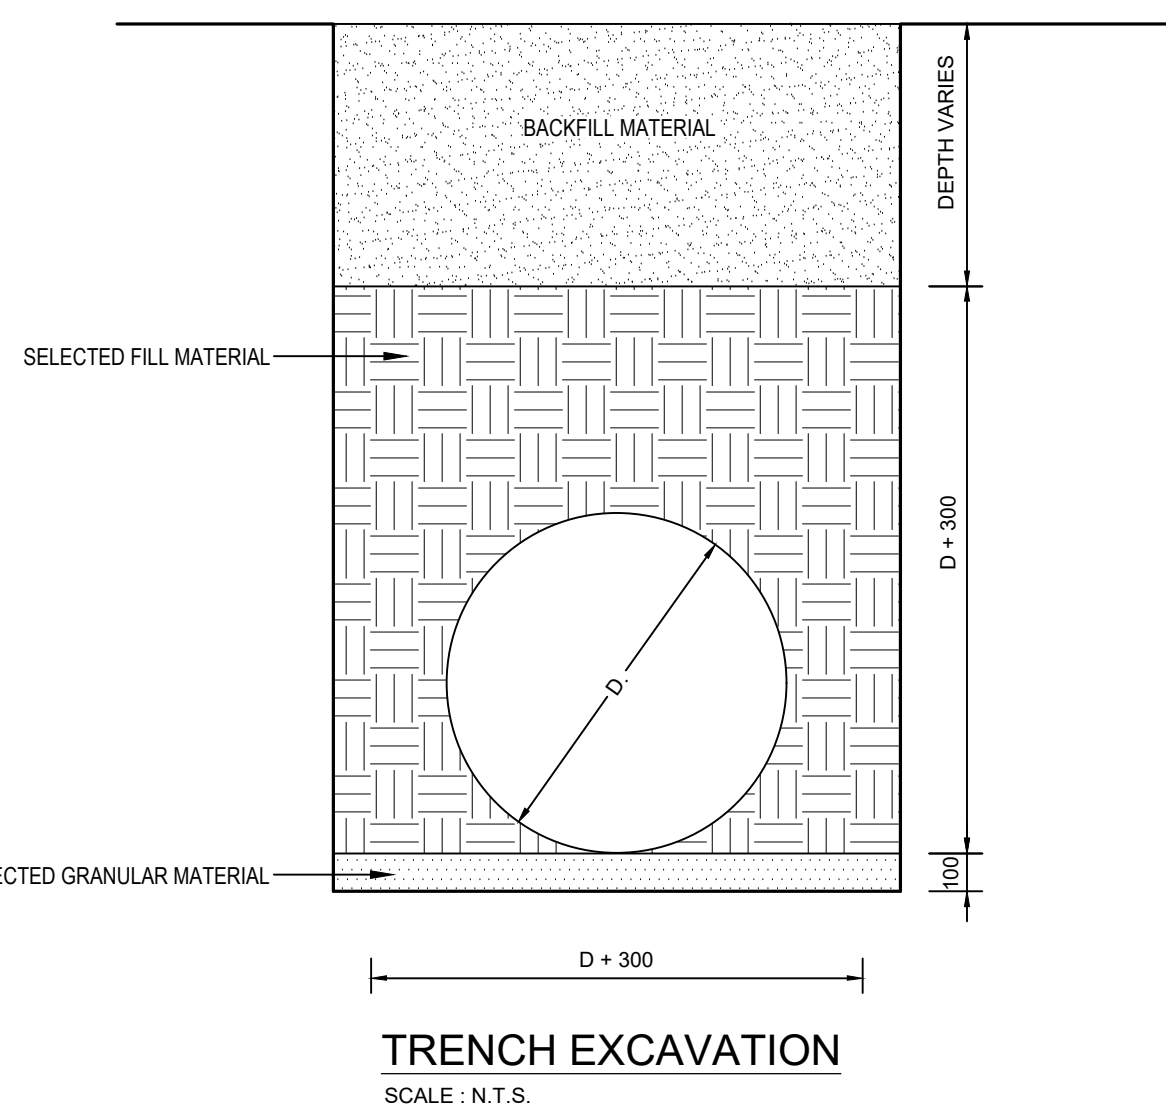

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No	Date	Revision Description	By

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**CLEINT**

**east london idz**

business streamlined

CLIENT APPROVAL :

DATE :

TENANT APPROVAL :

DATE :

**STORMWATER GENERAL DETAILS 1 OF 3**

Date: 01.05.2019 Drawn: Author

Scale: AS SHOWN Checked: Checker

Approved

Name: Approver Reg No: PArch5559

Signature: Date:

Practice: Osmond Lange Architects and Planners

Workstage

**FOR INFORMATION**

Drawing Number: 33722- GE1 -DET-2 Revision: N.T.S.